









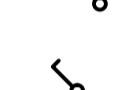
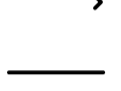

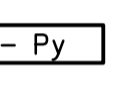

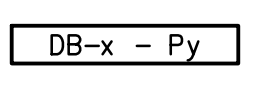







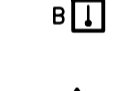

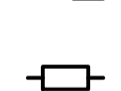
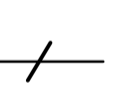

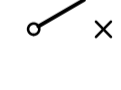
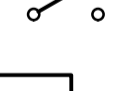
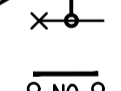
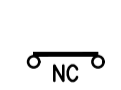




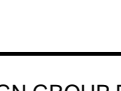



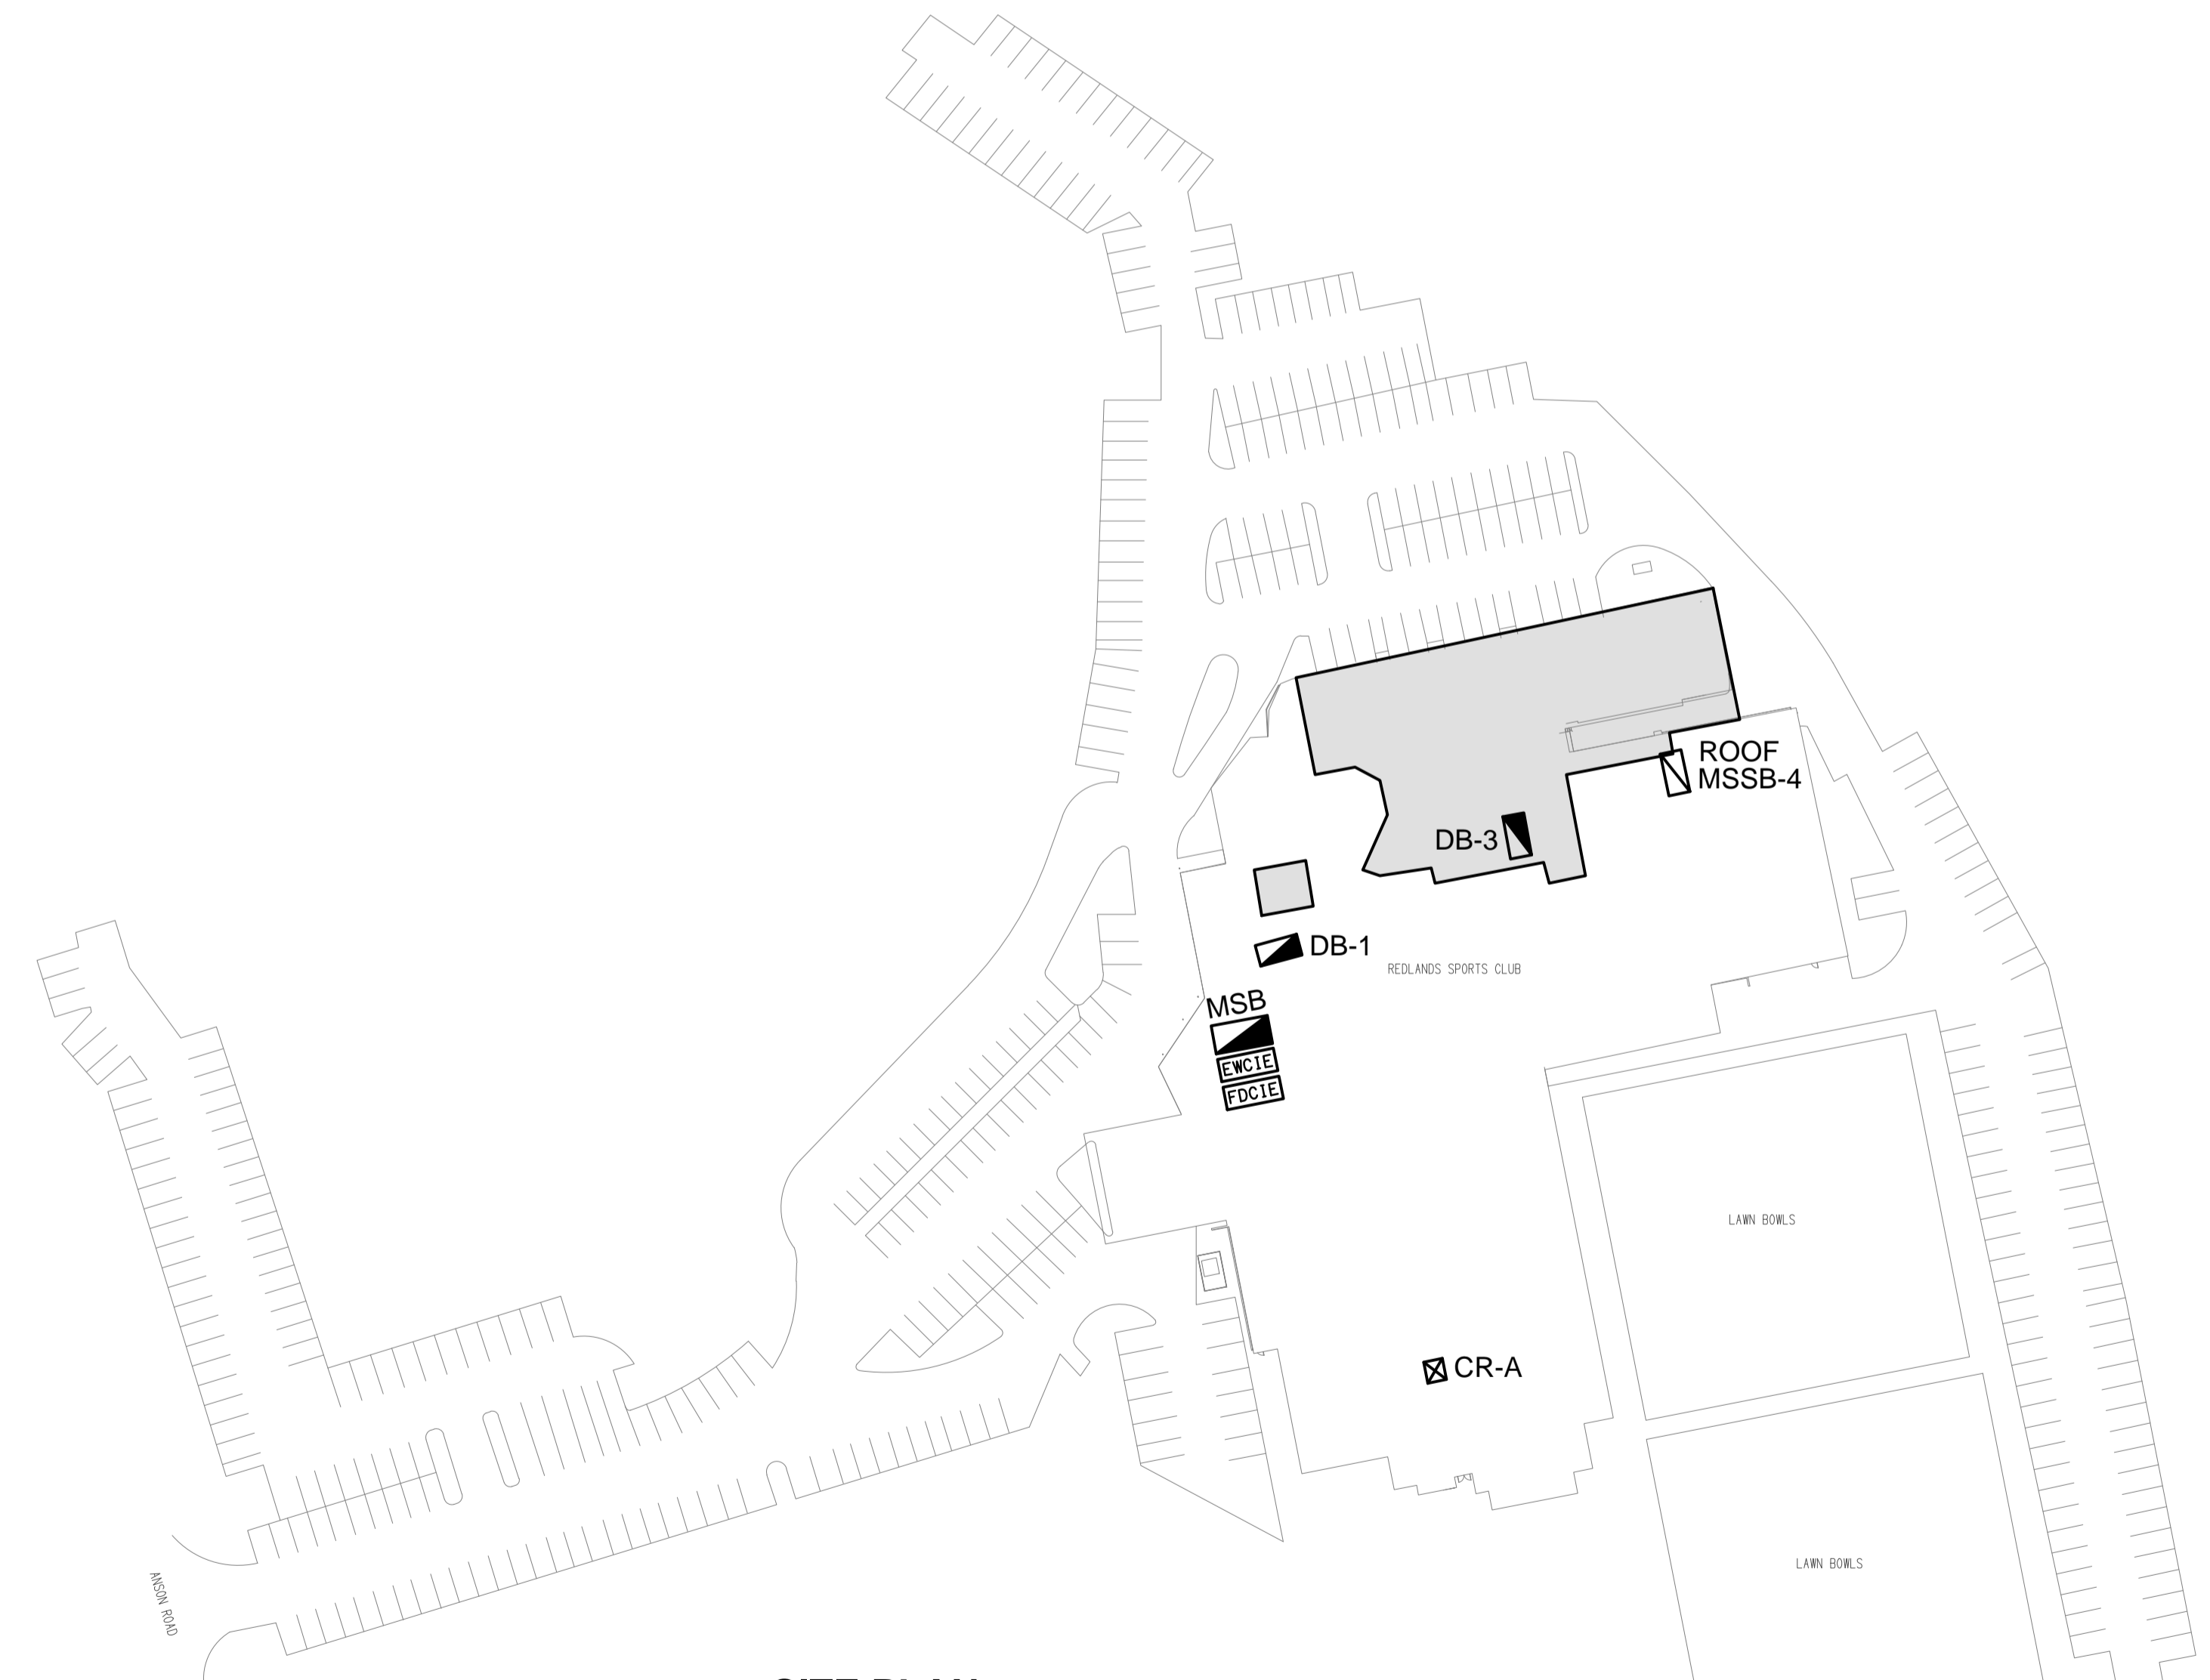
**LEGEND**

-  ELECTRICAL SERVICES SWITCHBOARD.
-  SWITCHBOARD / CONTROL PANEL NOT PROVIDED AS PART OF THE ELECTRICAL SUBCONTRACT.
-  SINGLE POWER OUTLET.
-  DOUBLE POWER OUTLET.
-  SPECIAL PURPOSE POWER OUTLET.
-  SINGLE PHASE ISOLATOR.
-  THREE PHASE ISOLATOR.
-  SIGNAGE CONNECTION.
-  JUNCTION BOX.
-  HAND DRYER CONNECTION.
-  LIGHTING CONTROL SWITCH PANEL, TYPE AS NOTED.
-  ONE-WAY LIGHT SWITCH.
-  TWO-WAY LIGHT SWITCH.
-  CIRCUIT LINE.
-  SWITCH LINE.
-  DB-x - Py POWER CIRCUIT DESIGNATION. DENOTES DB AND CIRCUIT.
-  xx LIGHTING CONTROL CHANNEL REFERENCE.
-  ELECTRICAL EQUIPMENT AS NOTED.
-  RJ45 COMMUNICATIONS OUTLET.
-  FIRE EVACUATION SPEAKER.
-  FIRE EMERGENCY WARNING CIE.
-  FIRE DETECTION CIE.
-  FIRE ALARM HORN.
-  THERMAL DETECTOR.
-  THERMAL DETECTOR, TYPE B SEALED.
-  THERMAL DETECTOR WITHIN DUCT.
-  SMOKE DETECTOR.
-  FUSE.
-  SINGLE PHASE.
-  THREE PHASE.
-  CIRCUIT BREAKER.
-  ISOLATOR.
-  RESIDUAL CURRENT DEVICE.
-  CONTACTOR - NORMALLY OPEN.
-  CONTACTOR - NORMALLY CLOSED.
-  REFER TO DETAIL NOTED FOR THE AREA SHOWN HATCHED. ADDITIONAL OUTLETS & FITTINGS MAY BE SHOWN ON DETAIL.
-  E1: GENERAL LED EMERGENCY LIGHT.
-  EX: EMERGENCY LED EXIT LIGHT.

**LEGEND**

-  Lx: LIGHT FITTING C/W NON-MAINTAINED EMERGENCY BATTERY PACK. TYPE AS NOTED.
-  L1: 300 x 600 FLUSH RECESSED LED PANEL LIGHT.
-  L2: 300 x 1200 FLUSH RECESSED LED PANEL LIGHT.
-  L3: 1200 SURFACE LED BATTEN C/W INTEGRAL SENSOR.
-  L4: EXISTING DOWNLIGHT TO BE RECOVERED FROM THE AREA OF DEMOLITION AND BE RELOCATED.
-  GL01: DECORATIVE DALI DIMMABLE GARDEN STAKE LIGHT.
-  LMP01: DECORATIVE TRAILING EDGE DIMMABLE TABLE LAMP.
-  LMP02: DECORATIVE TRAILING EDGE DIMMABLE TABLE LAMP.
-  HL01: DECORATIVE PENDANT HEAT LAMP.
-  HL02: LINEAR UNDER SHELF HEAT LAMP.
-  S1: REAR BAR DISPLAY DALI DIMMABLE LED STRIP LIGHT.
-  S2: BAR COUNTER PELMET DALI DIMMABLE LED STRIP LIGHT.
-  S3: REAR CAFE WALL DALI DIMMABLE LED STRIP LIGHT.
-  S4: CEILING COFFER DALI DIMMABLE LED STRIP LIGHT.
-  S5: CEILING COFFER DALI DIMMABLE LED STRIP LIGHT.
-  S6: WALL PELMET DALI DIMMABLE LED STRIP LIGHT.
-  S7: AMENITY WALL PELMET DALI DIMMABLE LED STRIP LIGHT.
-  S8: CAFE CEILING PELMET DALI DIMMABLE LED STRIP LIGHT.
-  S9: BAR DISPLAY SHELF SURROUND DALI DIMMABLE LED STRIP LIGHT.
-  WL01: DECORATIVE TRAILING EDGE DIMMED WALL LIGHT.
-  WL02: FOUR DECORATIVE FEATURE COLUMN TRAILING EDGE DIMMED WALL LIGHT.
-  WL03: DECORATIVE AMENITY ENTRY TRAILING EDGE DIMMED WALL LIGHT.
-  WL04: DECORATIVE AMENITY MIRROR TRAILING EDGE DIMMED WALL LIGHT.
-  PD01: DECORATIVE TRAILING EDGE DIMMED PENDANT LIGHT.
-  PD02: DECORATIVE TRAILING EDGE DIMMED PENDANT LIGHT.
-  PD03: DECORATIVE TRAILING EDGE DIMMED PENDANT LIGHT.
-  PD04: DECORATIVE TRAILING EDGE DIMMED PENDANT LIGHT.
-  PD05: DECORATIVE TRAILING EDGE DIMMED PENDANT LIGHT.
-  PD06: DECORATIVE TRAILING EDGE DIMMED PENDANT LIGHT.
-  PD07: DECORATIVE TRAILING EDGE DIMMED PENDANT LIGHT.
-  PD08: DECORATIVE TRAILING EDGE DIMMED PENDANT LIGHT.
-  PD09: DECORATIVE TRAILING EDGE DIMMED PENDANT LIGHT.
-  PD10: DECORATIVE TRAILING EDGE DIMMED PENDANT LIGHT.
-  PD11: GROUP OF THREE DECORATIVE TRAILING EDGE DIMMED PENDANT LIGHTS.
-  RD01: RECESSED DALI DIMMABLE LED DOWNLIGHT.
-  RD02: RECESSED DALI DIMMABLE LED DOWNLIGHT.
-  RD03: RECESSED DALI DIMMABLE LED DOWNLIGHT.

**NOTE**  
ALL ELECTRICAL PENETRATIONS THROUGH THE ROOF SHEETING ARE TO BE IN LINE WITH THE STRUCTURAL OR MECHANICAL SERVICES PENETRATIONS TO AVOID DEDICATED FLASHINGS FOR THE ELECTRICAL SERVICES.



**SITE PLAN**  
REFURBISHMENT WORKS SHADED  
SCALE 1:750

ELECTRICAL DESIGN GROUP BRISBANE  
PTY LTD  
ACN 092 710 793  
TRADING AS:  
ELECTRICAL DESIGN GROUP

THE COPYRIGHT OF THIS DRAWING  
REMAINS THE PROPERTY OF THE  
ELECTRICAL DESIGN GROUP.  
USE FIGURED DIMENSIONS  
IN PREFERENCE TO SCALE.  
ALL DIMENSIONS TO BE  
VERIFIED ONSITE.

**ELECTRICAL DESIGN GROUP**  
ELECTRICAL BUILDING SERVICES CONSULTANTS  
BRISBANE GOLD COAST  
P.O. Box 15, Sherwood Q.4075  
Phone: (07) 3278 4375  
Email: brisbane@edg.net.au  
Web: www.edg.net.au

PROJECT:  
**REDLANDS SPORTING CLUB  
REFURBISHMENT**  
ANSON ROAD, WELLINGTON POINT, QUEENSLAND

E	TENDER	17/06/2024
REV:	DESCRIPTION:	DATE:
DRAWING: <b>ELECTRICAL SERVICES LEGEND &amp; SITE PLAN</b>		
SCALE: 1:750	AT A1	PROJECT NO: <b>C3204a</b>
		DRAWING NO: <b>E01</b>
		REVISION: <b>E</b>